




 Impianto fotovoltaico

**Classe Valore Ecologico**

-  Molto bassa
-  Bassa
-  Media
-  Alta
-  Molto alta




**REGIONE BASILICATA**

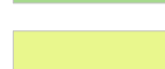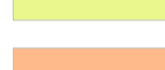



**COMUNE DI MATERA**  
PROVINCIA DI MATERA

**PROGETTO DEFINITIVO**  
 IMPIANTO FOTOVOLTAICO AD INSEGUIMENTO SOLARE DA 19,9584 MWp  
 DA REALIZZARSI IN C.da "MONTE D'ORO" NEL COMUNE DI MATERA

|         |                  |                                   |
|---------|------------------|-----------------------------------|
| TAVOLA: | Tavola A.13.a.12 | <b>Carta del Valore Ecologico</b> |
| SCALA:  | 1:10000          |                                   |
| DATA:   | novembre 2021    |                                   |
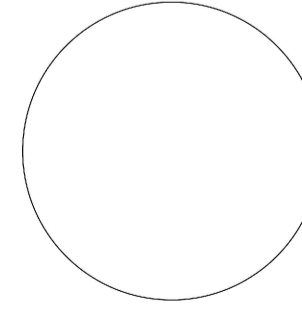
|                                      |  |  |
|--------------------------------------|--|--|
| Committente:                         | AMBRA SOLARE 26 - S.R.L.   | <br> |
| Progettista impianti elettrici:      | Ing. Paolo Acquasanta  |   |
| Collaboratori:                       | Ing. Eustachio Santarsia<br>Studio Tecnico Lantri S.r.l.s                            |  |
| Opere edili e consulenza Ambientale: | Ing. Paolo Acquasanta<br>Arch. Cosimo Damiano Belfiore<br>Geom. Rocco Donato Lorusso |  |
| Consulenza Agronomica:               | Bioinnova srls   |  |
| Archeologo:                          | Dott. Antonio Bruscella  |  |
| Geologo:                             | Dott. Maurizio Giacomino   |  |

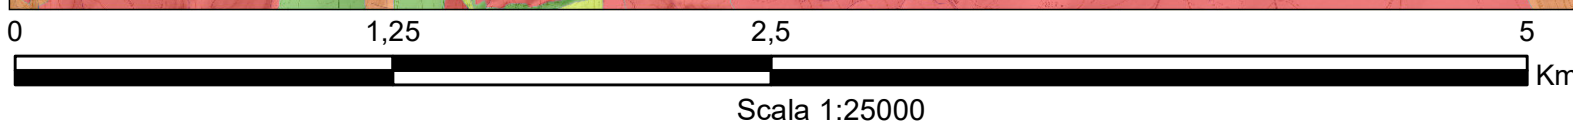

Fonte CTR: servizio WMS della Regione Basilicata  
 Fonte Carta della Natura: GeoPortale ISPRA