

# IMPIANTO AGRIVOLTAICO AD INSEGUIMENTO SOLARE DA 19,9584 MWp DA REALIZZARSI IN LOCALITA' "BOLETTIERI" NEL COMUNE DI GROTTOLE



## CARTA DELLA VISIBILITA' DEL SUOLO

REGIONE BASILICATA

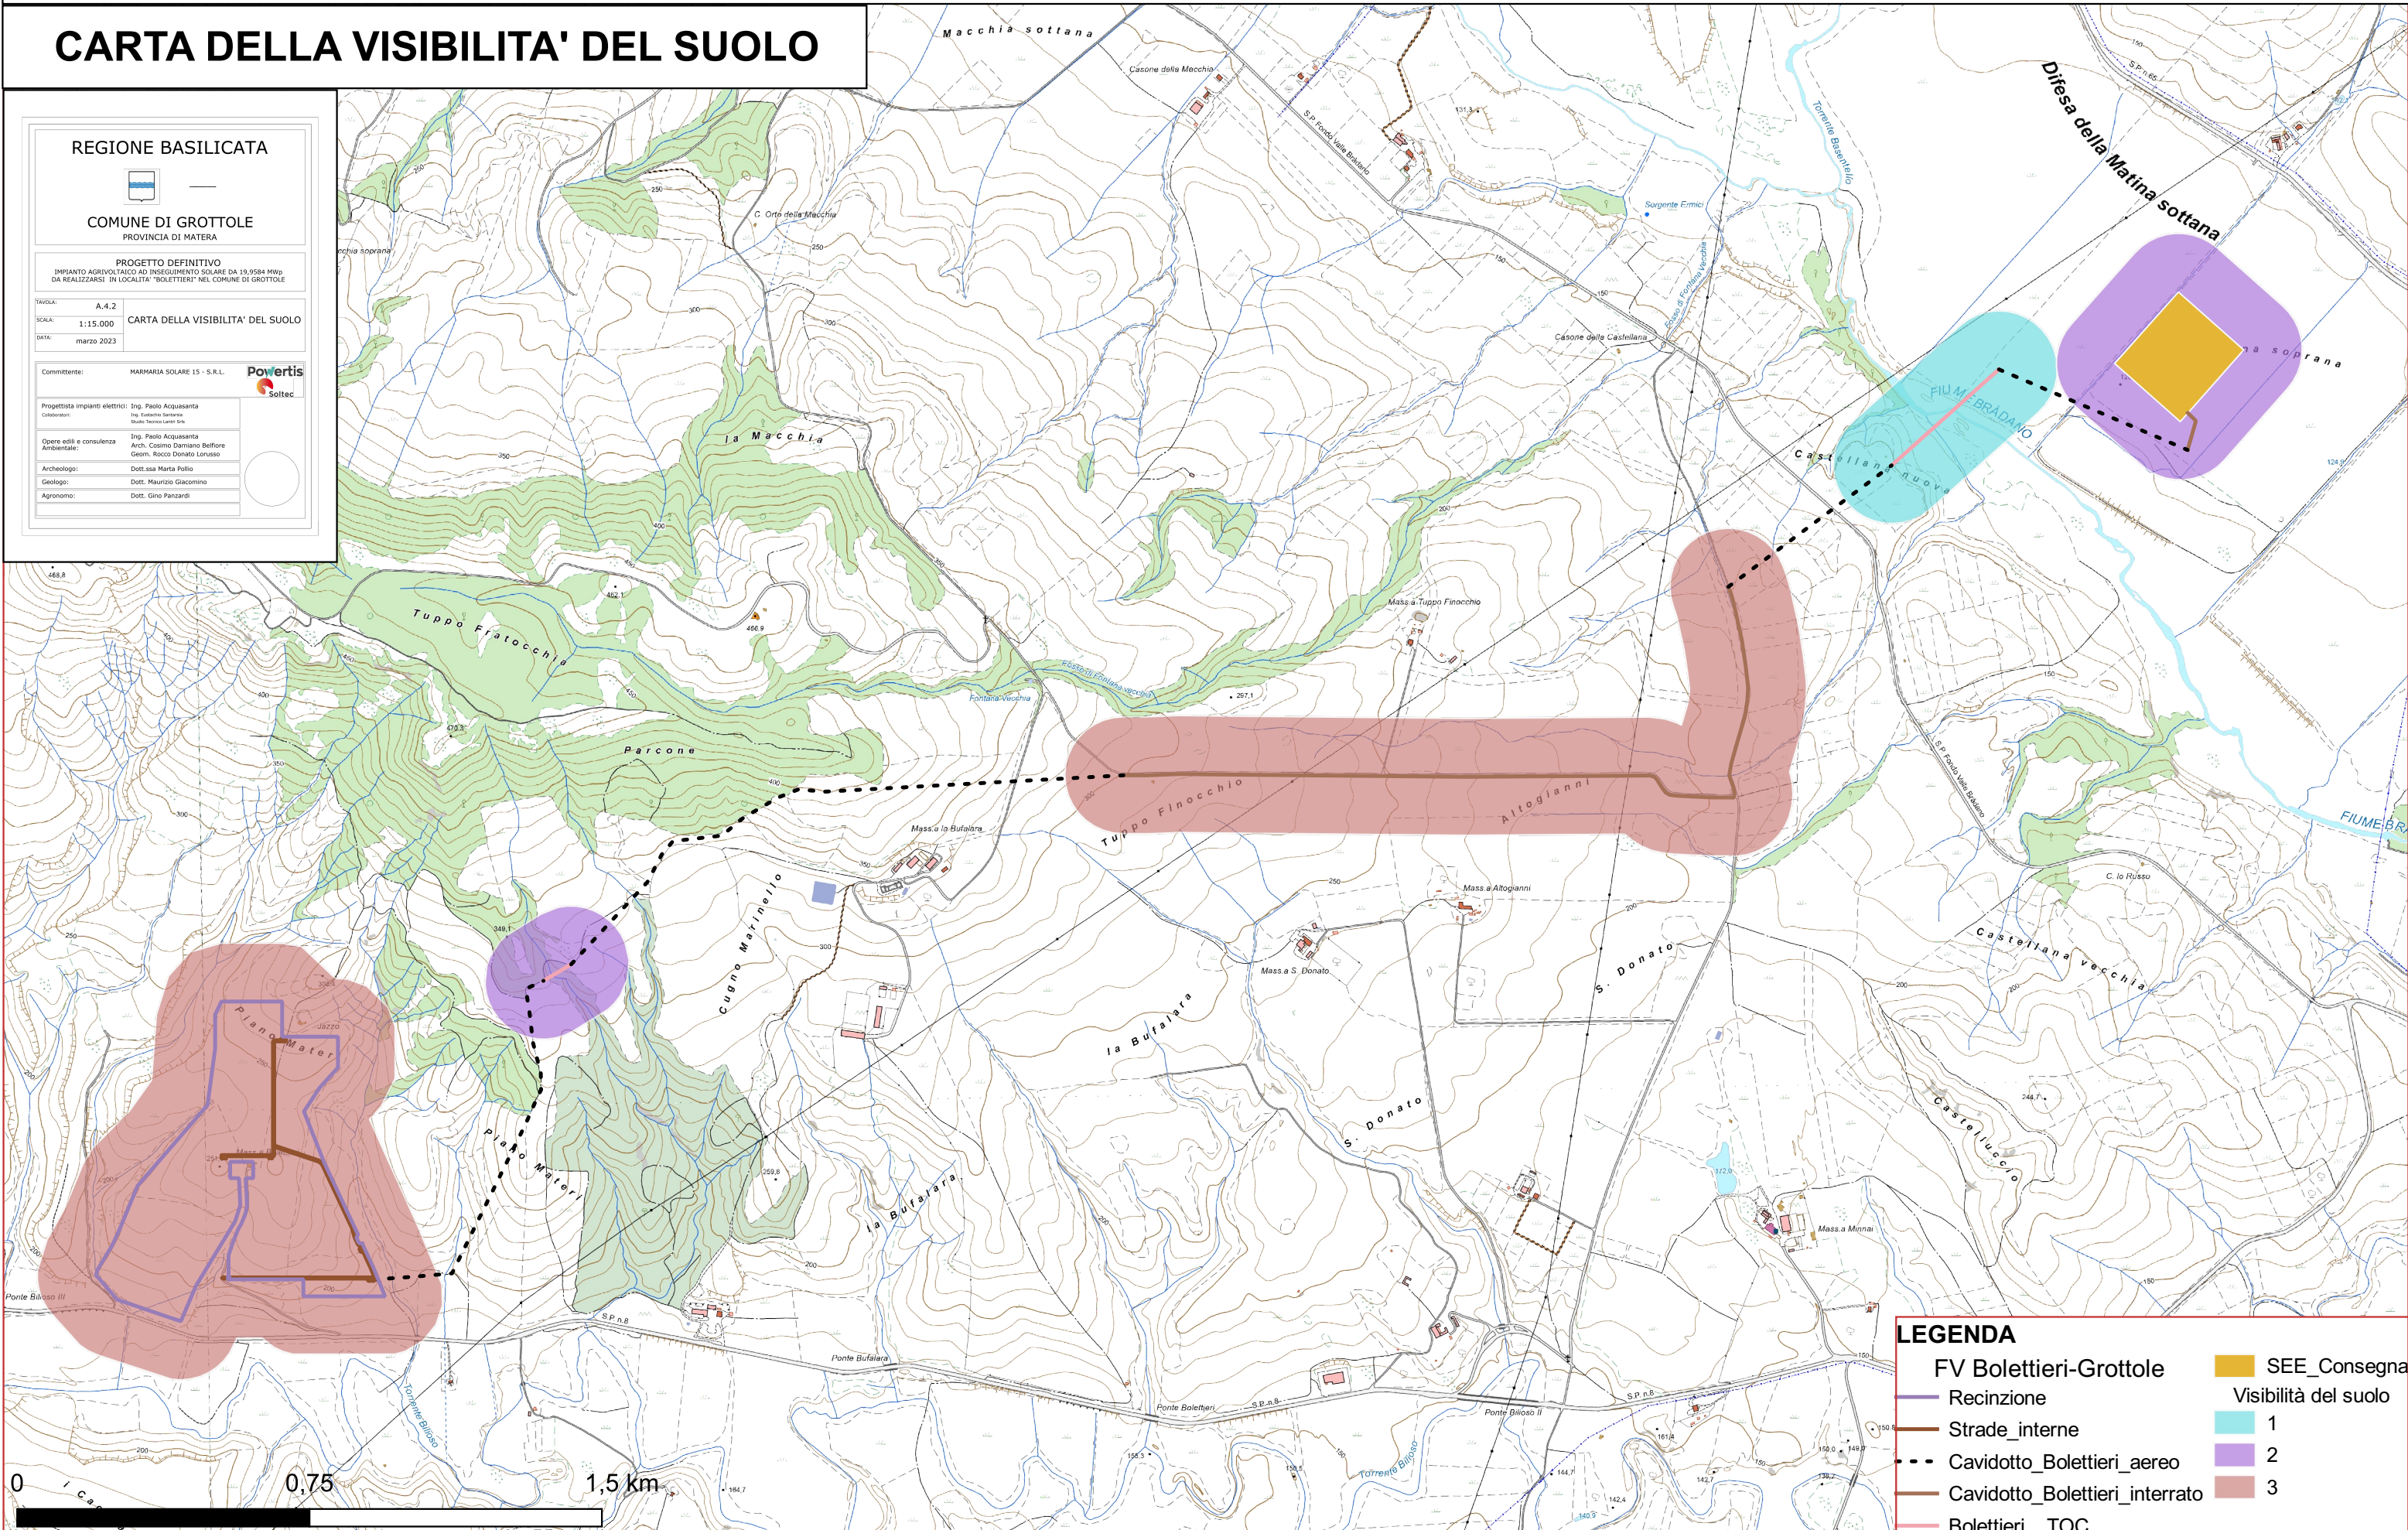
COMUNE DI GROTTOLE  
PROVINCIA DI MATERA

PROGETTO DEFINITIVO  
IMPIANTO AGRIVOLTAICO AD INSEGUIMENTO SOLARE DA 19,9584 MWp  
DA REALIZZARSI IN LOCALITA' "BOLETTIERI" NEL COMUNE DI GROTTOLE


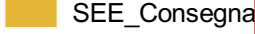


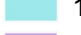
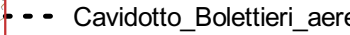

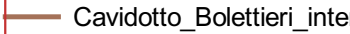


TAVOLA: A.4.2  
SCALA: 1:15.000  
DATA: marzo 2023  
CARTA DELLA VISIBILITA' DEL SUOLO

Committente: MARMARIA SOLARE 15 - S.R.L.  

Progettista impianti elettrici: Ing. Paolo Acquasanta  
Collaboratori: Ing. Eusebio Santese, Studio Techno Lattini Srl  
Opere edili e consulenza: Ing. Paolo Acquasanta  
Ambientale: Arch. Cosimo Damiano Belliere, Geom. Rocco Donato Lorusso  
Archeologo: Dott.ssa Marta Pollio  
Geologo: Dott. Maurizio Giacomino  
Agronomo: Dott. Gino Panzardi



**LEGENDA**

 FV Bolettieri-Grottole	 SEE_Consegna
 Recinzione	Visibilità del suolo
 Strade_interne	 1
 Cavidotto_Bolettieri_aereo	 2
 Cavidotto_Bolettieri_interrato	 3
 Bolettieri TOC	

